PROJECT:

CITY OF OSHKOSH OSHKOSH WILLIAM WATERS PLAZA

105 WASHINGTON AVE, OSHKOSH, WI 54901

OWNER:

CITY OF OSHKOSH PO BOX 1130 OSHKOSH, WI 54903


ARCHITECT/ ENGINEER:

MSA PROFESSIONAL SERVICES, INC. 1230 SOUTH BLVD BARABOO, WI 53913 PH: 608-356-2771 (GENERAL OFFICE)

PROJECT LOCATION:



SYMBOLS:

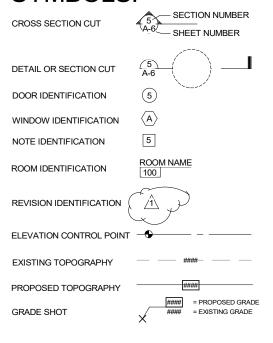

MATERIAL SYMBOLS:

EARTHWORK	EARTH	FILL		
CONCRETE	CAST-IN- PLACE	GROUT		
MASONRY	BRICK	CMU		
METAL	STEEL			
WOOD	FINISH	ROUGH	BLOCKING	PLYWOO
INSULATION	BATT [RIGID	LOOSE	
GLASS	LARGE SCALE	SMALL SCALE		
FINISHES	GYPSUM	PLASTIC	TILE	

ADDDEN/IATIONIC.

AВ	BREVIATION	JNS	•
AB	ANCHOR BOLT	JT	JOINT
A/C	AIR CONDITIONER	LAV	LAVATORY
ADJ	ADJACENT	MAT'L	MATERIAL
AFF	ABOVE FINISH FLOOR	MECH	MECHANICAL
ALT	ALTERNATE	MH	MANHOLE
ALUM	ALUMINUM	MIN	MINIMUM
APPROX	APPROXIMATE(LY)	MO	MASONRY OPENING
BD	BOARD	MR	MOISTURE RESISTANT
BIT	BITUMINOUS	MTL	METAL
BLDG	BUILDING	NIC	NOT IN CONTRACT
BLK	BLOCK	NTS	NOT TO SCALE
BLKG	BLOCKING	OC	ON CENTER
BM	BEAM	OPP HD	OPPOSITE HAND
BRG	BEARING	PC	PRECAST CONCRETE
BUR	BUILT UP ROOF	PDF	POWER DRIVEN FASTENER
CONC	CONCRETE	PLAM.	PLASTIC LAMINATE
CJ	CONTROL JOINT /	PLBG	PLUMBING
	CONSTRUCTION JOINT	PT	PRESERVATIVE TREATED
CLG	CEILING	PLYWD	PLYWOOD
CMU	CONCRETE MASONRY UNIT	PSF	POUNDS PER SQUARE FOOT
COL	COLUMN	PSI	POUNDS PER SQUARE INCH
CONTR	CONTRACTOR	P/L	PROPERTY LINE
CONT	CONTINUOUS		
CPT	CARPET	QT	QUARRY TILE
CT	CERAMIC TILE	RCP	REFLECTED CEILING PLAN
DBL	DOUBLE	RD	ROOF DRAIN
DF	DRINKING FOUNTAIN	REINF	REINFORCING OR REINFORC
DIA	DIAMETER	REQ'D	REQUIRED
DIM	DIMENSION	ROW	RIGHT OF WAY
DS	DOWN SPOUT	RO	ROUGH OPENING
DT	DRAIN TILE	SIM	SIMILAR
EL	ELEVATION	SPECS	SPECIFICATIONS
EQ	EQUAL	SS	STAINLESS STEEL
EWC	ELECTRIC WATER COOLER	SQ	SQUARE
EXP	EXPANSION	SF	SQUARE FOOT
EXT	EXTERIOR	S&V	STAIN AND VARNISH
FE	FIRE EXTINGUISHER	STD	STANDARD
FD	FLOOR DRAIN	STL	STEEL
FDN	FOUNDATION	T&B	TOP AND BOTTOM
FIN	FINISH(ED)	T&G	TONGUE & GROOVE
FLR	FLOOR	TB	TOP OF BEAM
FRP	FIBERGLASS REINFORCED PANEL	TF	TOP OF FOOTING
FT	FOOT OR FEET	TW	TOP OF WALL
FTG	FOOTING	THRU	THROUGH
GALV	GALVANIZED	TYP	TYPICAL
GC	GENERAL CONTRACTOR	UNEX	UNEXCAVATED
GYP	GYPSUM	UNO	UNLESS NOTED OTHERWISE
HB	HOSE BIBB	UV	UNIT VENTILATOR
HDR	HEADER	VCT	VINYL COMPOSITION TILE
HGT	HEIGHT	VERT	VERTICAL
HM	HOLLOW METAL	VWC	VINYL WALL COVERING
HORIZ	HORIZONTAL	WD	WOOD
HTG	HEATING	WH	WATER HEATER
HVAC	HEATING HEATING/VENTILATING/	W/	WITH
	AIR CONDITIONING	W/O	WITHOUT
INSUI	INSLII ATION	WT	WEIGHT

WIRE WELDED MESH

INDEX:

GENERAL

T1.0 TITLE SHEET T1.1 PERSPECTIVES

SITE

C1.1 SITE PLAN

STRUCTURAL

S1.0 FOUNDATION PLAN S1.1 FRAMING PLAN


ARCHITECTURAL

A1 1 FLOOR PLAN A2.1 EXTERIOR ELEVATIONS A2.2 EXTERIOR ELEVATIONS

LAKITIWOKK	EARTH	FILL		
CONCRETE	CAST-IN- PLACE	GROUT		
MASONRY	BRICK	CMU		
METAL	STEEL			
WOOD	FINISH	ROUGH	BLOCKING	PLYWOO
INSULATION	BATT	RIGID	LOOSE	
GLASS	LARGE SCALE	SMALL SCALE		
FINISHES	GYPSUM	PLASTIC	TILE	





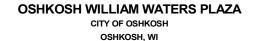
















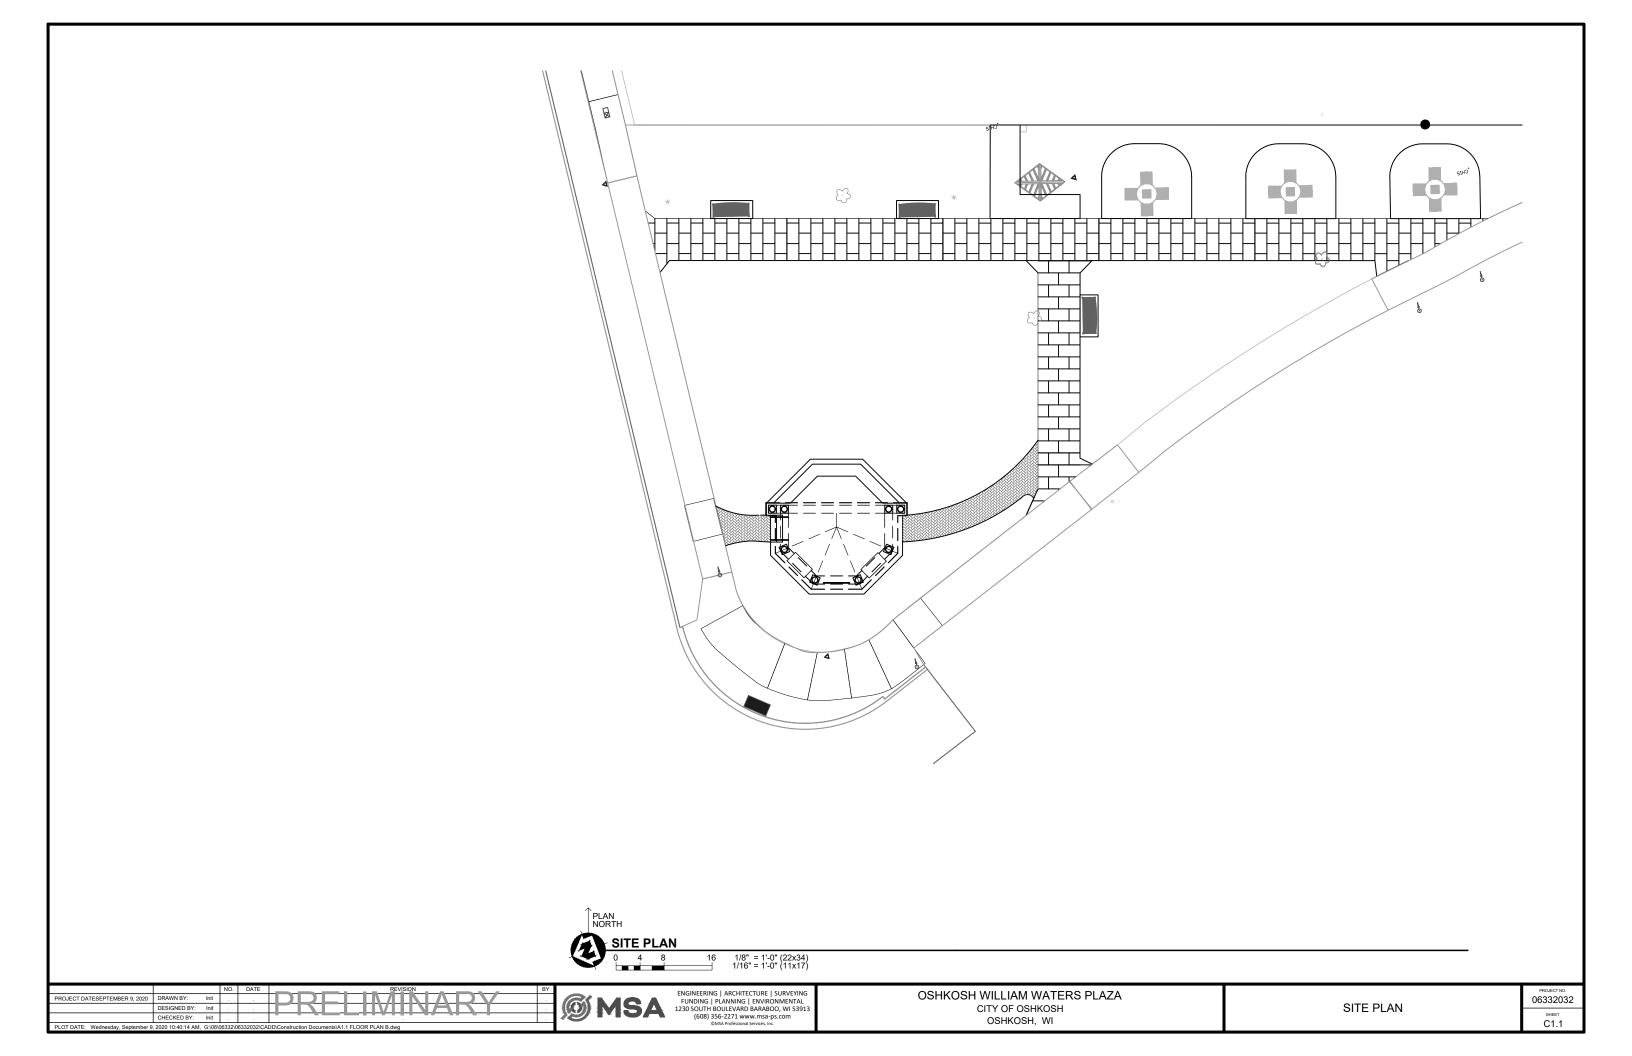

DESIGN LOADINGS BUILDING CATEGORY II SEISMIC DESIGN DATA SEISMIC IMPORTANCE FACTOR, Ie-WIND LOAD MAPPED SPECTRAL RESPONSE ACCELERATIONS BASIC WIND SPEED-RISK CATEGORY-WIND EXPOSURE 0.0368 INTERNAL PRESSURE COEFFICIENT— COMPONENTS AND CLADDING EXTERIOR WALLS, DOORS, WINDOWS SPECTURAL RESPONSE COEFFICIENTS +/- 0.18 0.064 Sds SEISMIC DESIGN CATAGORY-AND LOUVERS-Α xx psf xx psf SEISMIC SITE CLASS-D SEISMIC RESPONSE COEFICIENT, Cs——RESPONSE MODIFICATION FACTOR—— 0.01 3.0 ADDITIONAL DEAD LOADS SUPERIMPOSED DEAD LOAD DECORATIVE PRECAST CLADDING — ROOF w/ CEILING 75 psf 12 psf LIVE LOADS ROOF LIVE LOAD (MINIMUM)-20 psf SNOW LOAD GROUND SNOW LOAD, Pg — FLAT-ROOF SNOW LOAD, Pf 35 psf 29.4 psf 1.00 1.00 1.20 SNOW EXPOSURE FACTOR, Ce-SNOW LOAD FACTOR, I THERMAL FACTOR, Ct SLOPE ROOF SNOW LOAD, Ps-29.4 psf

DESIGN STRESSES									
CAST-IN-PLACE CONCRETE									
FOOTINGS	- f'c = 4000 psi - f'c = 4000 psi								
STEEL									
REINFORCING —	— fy = 60 ksi								
BOLTS									
ANCHOR————————————————————————————————————	F1554, GRADE 36WEDGE TYPE								
SOIL BEARING PRESSURE CAPACITY									
ASSUMED MINIMUM—	— q = 1500 psf								

STEEL REINFORCING	
MIN CLEAR COVER, UNO	
FOUNDATION WALLS #5 BARS & SMALLER — #6 BARS & LARGER —	
NON-STRUCTURAL SLABS ON GRADE BOTTOM & SIDES TOP	
FOOTINGS AND STRUCTURAL SLABS ON GRADE BOTTOM & SIDES — TOP—	
NOTES	
1. LAP BARS 36" AT SPLICES.	

FOOTING SCHEDULE										
MARK	FOOTING SIZE	FOOTING REINFORCING	REMARKS							
F-1	3' - 0" WIDE x 12" DEEP	(4) - #5 BARS, CONT.								
F-2	3' - 9" WIDE x 12" DEEP	(5) - #5 BARS, CONT.								
F-3	4' -0" WIDE x 12" DEEP	(5) - #5 BARS, CONT.								
F-4	2'-8" WIDE x 4'-8" LONG x 12" DEEP	(5) - #5 BARS, TRANSVERSE (3) - #5 BARS, LONGITUDINAL								
REMAF	RKS									
1. X										
2. X										

FOUNDATION LEGEND

I COMBATION ELCEND			
TOP OF WALL ELEVATION— TOW=100"-0" —————————————————————————————————		<u> </u>	
CONCRETE WALL & FOOTING -			
CONCRETE COLUMN FOOTING -		╼ᆍ╣╟	٦
CONCRETE PIER -		 > -	1
FOOTING STEP —	→ ⟨²/2	P-1	F-6
FOOTING DESIGNATION -		—>∑	/
COLUMN FOOTING MARK - SEE FOOTING SCHEDULE			/
- SEE FOOTING SCHEDULE			

GENERAL FOUNDATION NOTES

- A. CONTRACTOR TO COORDINATE STRUCTURAL, ARCHITECTURAL, HVAC, AND PLUMBING PLANS FOR DETAILS, DIMENSIONS, ELEVATIONS, OPENINGS, INSERTS, ETC. NOTIFY ARCHITECT OF ANY VARIANCE BEFORE COMMENCING CONSTRUCTION.
 B. IN NO CASE SHALL STRUCTURAL ALTERATIONS OR WORK
- AFFECTING A STRUCTURAL MEMBER BE MADE, UNLESS APPROVED BY ENGINEER.
 C. SIMILAR PORTIONS OF THE BUILDING SHALL HAVE SIMILAR
- DETAILING, UNLESS NOTED OTHERWISE
- D. FOOTINGS SHALL BE CENTERED ABOUT THE WALLS, UNLESS NOTED OTHERWISE. E. PROVIDE 3'-0"x3'-0" CORNER BARS IN FOUNDATION WALL AT

CORNERS BARS SHALL BE SAME SIZE AND LOCATION OF THE HORIZONTAL REINFORCING.

KEYNOTES - FOUNDATION PLAN

1.	Χ	
2.	Х	
3		

F1	TOW = 99'-0" TYP
	TOF = 95'-0" TYP
F1 // /	
	\\\\\\\\\\\\\\\\\\\\\\\\\\\\\\\\\\\\\\
F4	
12" REINFORCED CONCRETE STRUCTURAL SLAB	
T/EL = 100'-0"	
`\\\\\\\\\\\\\\\\\\\\\\\\\\\\\\\\\\\\\\	
F3	F3
~	
F3	



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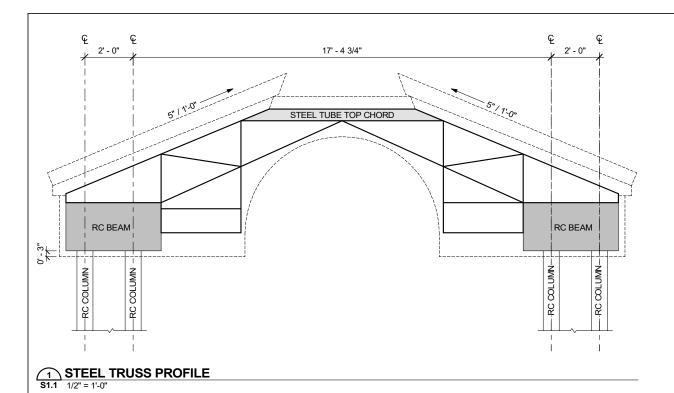


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OSHKOSH WILLIAM WATERS PLAZA CITY OF OSHKOSH OSHKOSH, WI

FOUNDATION PLAN

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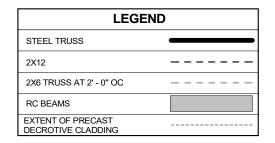



F 17'-4 3/4"

2x6

2x72

TRUSS GIRDER PROFILE
S1.1 1/2" = 1'-0"



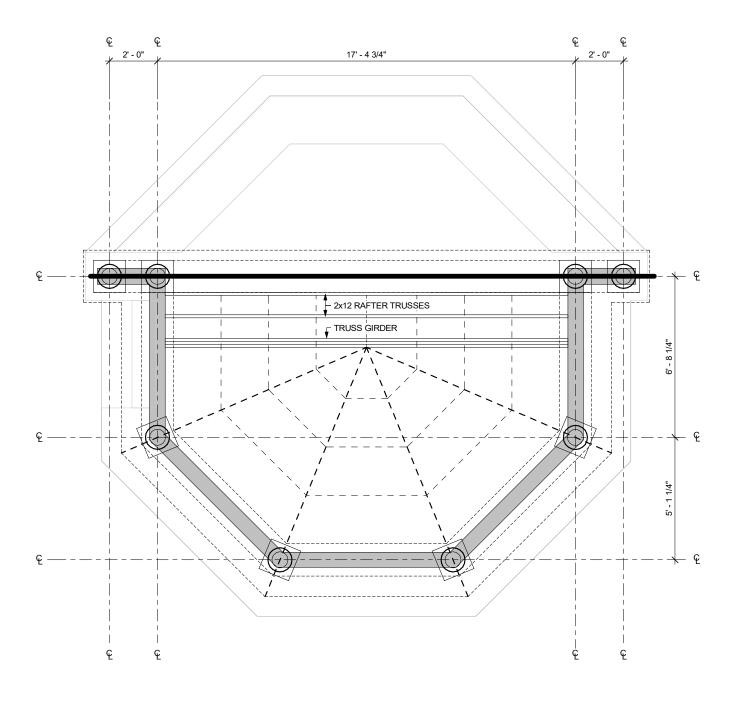



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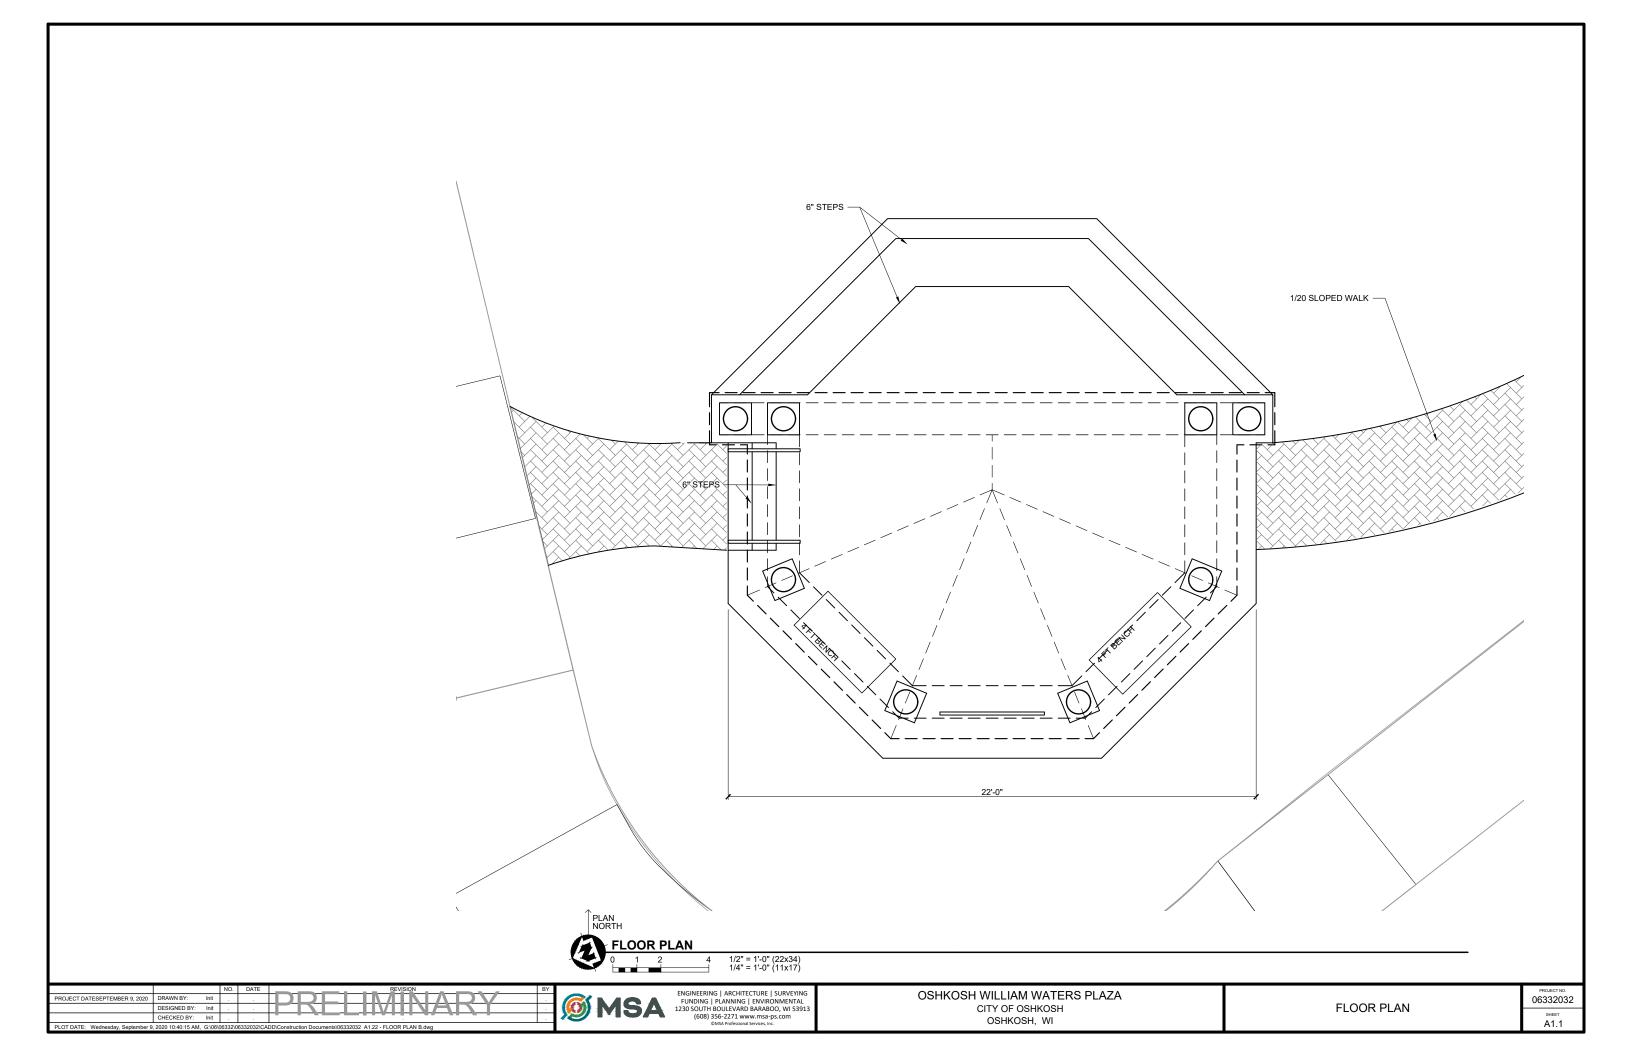
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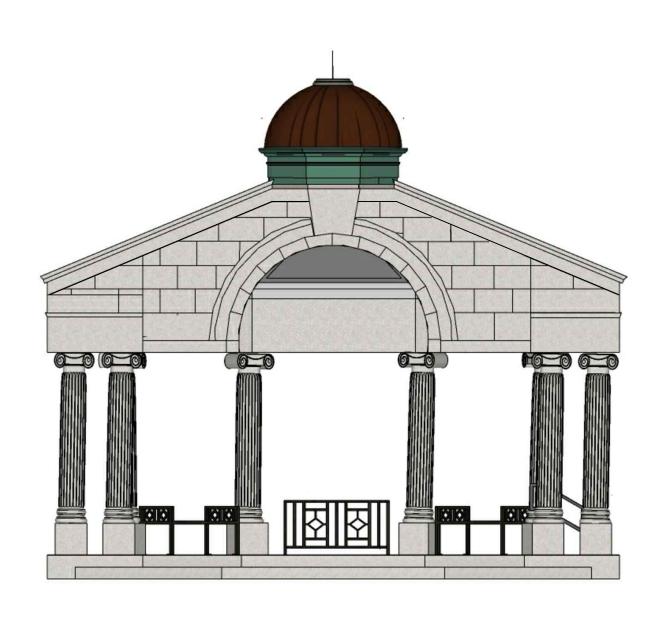
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CITY OF OSHKOSH
OSHKOSH, WI


FRAMING PLAN

PROJECT NO. 06332032

SHEET S1.1





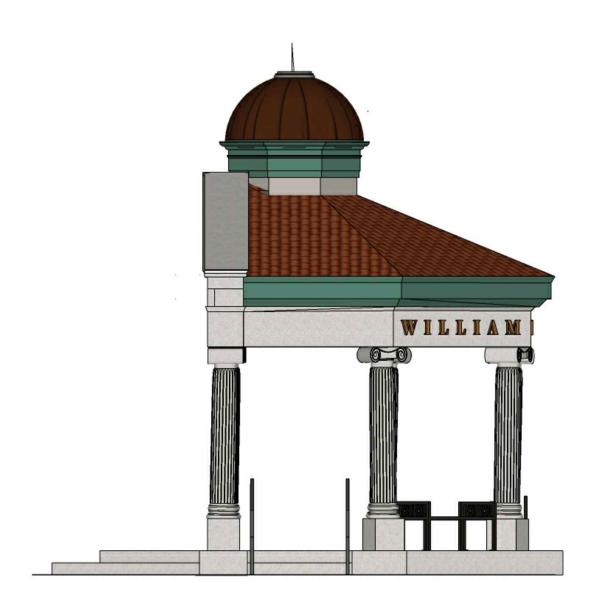

NORTH ELEVATION

WEST ELEVATION

4 1/2" = 1'-0" (22x34) 1/4" = 1'-0" (11x17)

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PROJECT DATESEPTEMBER 9, 2020	DRAWN BY:	Init					l,
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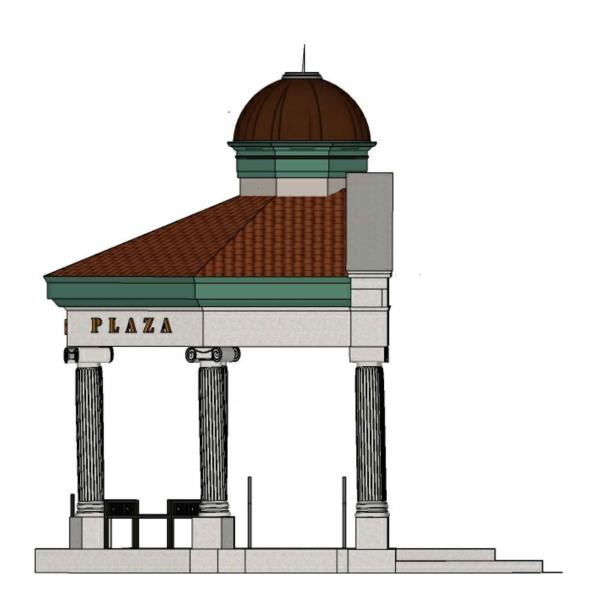
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EXTERIOR ELEVATIONS

06332032 A2.1





SOUTH ELEVATION

0 1 2 4 1/2" = 1'-0" (22x34)
1/4" = 1'-0" (11x17)

EAST ELEVATION

0 1 2 4 1/2" = 1'-0" (22x34)
1/4" = 1'-0" (11x17)

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EXTERIOR ELEVATIONS